

Exhibit A

Grand Oaks Phases 2 and 3 PD Plan



GRAND OAKS PHASES 2 AND 3 PLANNED DEVELOPMENT

CITY OF OCALA, FLORIDA

SECTIONS 25, 36 & 37, TOWNSHIP 15 SOUTH, RANGE 21 EAST

PARCEL IDS: 23930-000-00, 23930-002-00, 23930-003-00,
23930-005-00, 23930-003-01, 23930-003-03

APRIL 2024

TRAFFIC:

Land Use	LUC	Intensity	Daily Trips	AM Peak Hour of Adjacent		PM Peak Hour of Adjacent	
				Total	In	Total	In
Approved PUD Uses ¹							
	220	474 DU	2,996	236	47	189	278
	710	30,000 Sq Ft	528	72	63	9	45
		Subtotal	3,524	308	110	198	323
Proposed Development ²							
	220	48 DU	383	38	9	29	41
	221	480 DU	2,243	40	46	154	188
	710	30,000 Sq Ft	407	58	52	7	61
		Subtotal	3,033	297	107	190	290
Difference (proposed uses - approved trips)				-491	-11	-3	-33

Note 1: Trip Generation is from the approved Grand Oaks Town Center (Stolen Hours) PUD (17A11-0001, approved February 24, 2012)

Note 2: Trip Generation for the proposed uses is calculated using the following data from ITE's Trip Generation, 11th Edition.

Multifamily Residential (Low-Rise) [ITE 220]		
Daily	T = 6.41(X) + 75.31 (X is the Number Dwelling Units)	
AM Peak Hour of Adjacent Street	T = 0.31(X) + 22.85 (X is the Number Dwelling Units; 24% in, 76% out)	
PM Peak Hour of Adjacent Street	T = 0.43(X) + 20.55 (X is the Number Dwelling Units; 63% in, 37% out)	
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PM Peak Hour of Adjacent Street	T = 0.39(X) + 0.34 (X is the Number Dwelling Units; 61% in, 39% out)	
General Office Building [ITE 710]		
Daily	Ln(T) = 0.87 Ln(X) + 3.05 (X is 1000 Sq. Ft. GFA)	
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UTILITY PROVIDERS:

UTILITY COMPANIES		
UTILITY COMPANY	CONTACT PERSON	PHONE NUMBER
LUMEN - LOCAL	JOHN PLAMONDON	(352) 425-4444
LUMEN - NATIONAL	TIM FARMER	(252)-423-1035
COX CABLE	PAUL CHRISTOPHER	(352)-229-6600
OCALA - FIBER	BILLY WEAKLAND	(352) 401-6906
OCALA - ELECTRIC	PAUL SOOKDEO	(352)-401-6922
OCALA WATER AND SEWER	RICHARD RAGOSTA	(352)-351-6793
TECO GAS	LANDON MEAHL	(407)-408-5566

OVERHEAD ELECTRIC NOTES:

- PER CITY ORDINANCE (118-101-(a)-(6)) TREES SHALL NOT BE PLANTED WITHIN 30' OF OCALA ELECTRIC UTILITY'S OVERHEAD ELECTRIC TRANSMISSION LINE.
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GENERAL NOTES:


WATER:
POTABLE WATER WILL BE PROVIDED BY CITY OF OCALA.

SEWER:
WASTEWATER WILL BE PROVIDED BY CITY OF OCALA.

FEMA DESIGNATION:
PER FEMA FIRM PANEL NUMBER 12083C0518E EFFECTIVE APRIL 19, 2017, THE MAJORITY OF THE PROJECT AREA LIES IN ZONE "X", AN AREA DETERMINED TO BE OUTSIDE THE 0.2% ANNUAL CHANCE FLOOD PLAIN, ACCORDING TO THE FEDERAL EMERGENCY MANAGEMENT AGENCY FLOOD INSURANCE RATE MAP. A PORTION OF THE NORTH PROJECT AREA LIES IN ZONE "AE", AN AREA DETERMINED TO BE WITHIN THE 0.2% ANNUAL CHANCE FLOOD PLAIN WITH A BASE FLOOD ELEVATION OF 80.0'.

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THIS PROJECT SHALL UTILIZE ON-SITE WATER RETENTION AREAS SIZED TO MEET THE REGULATORY REQUIREMENTS OF THE CITY OF OCALA AND THE ST. JOHN'S RIVER WATER MANAGEMENT DISTRICT. ALL RETENTION AREAS AND DRAINAGE SYSTEM WILL BE OWNED AND MAINTAINED BY THE PROPERTY OWNER. PROPOSED DRAINAGE RETENTION AREAS SHALL HAVE MAXIMUM SIDE SLOPES OF 4:1.

MAINTENANCE:
THE PROPERTY OWNER SHALL PROVIDE PERPETUAL MAINTENANCE FOR THE PRIVATE STREETS, NEW & REPLACEMENT STREET SIGNS, DRAINAGE SYSTEMS AND COMMON AREAS OF THE DEVELOPMENT AND FOR OPERATION AND MAINTENANCE OF ALL PRIVATE FACILITIES. ROADS DESIGNATED FOR DEDICATION TO THE PUBLIC SHALL BE MAINTAINED BY THE CITY OF OCALA.

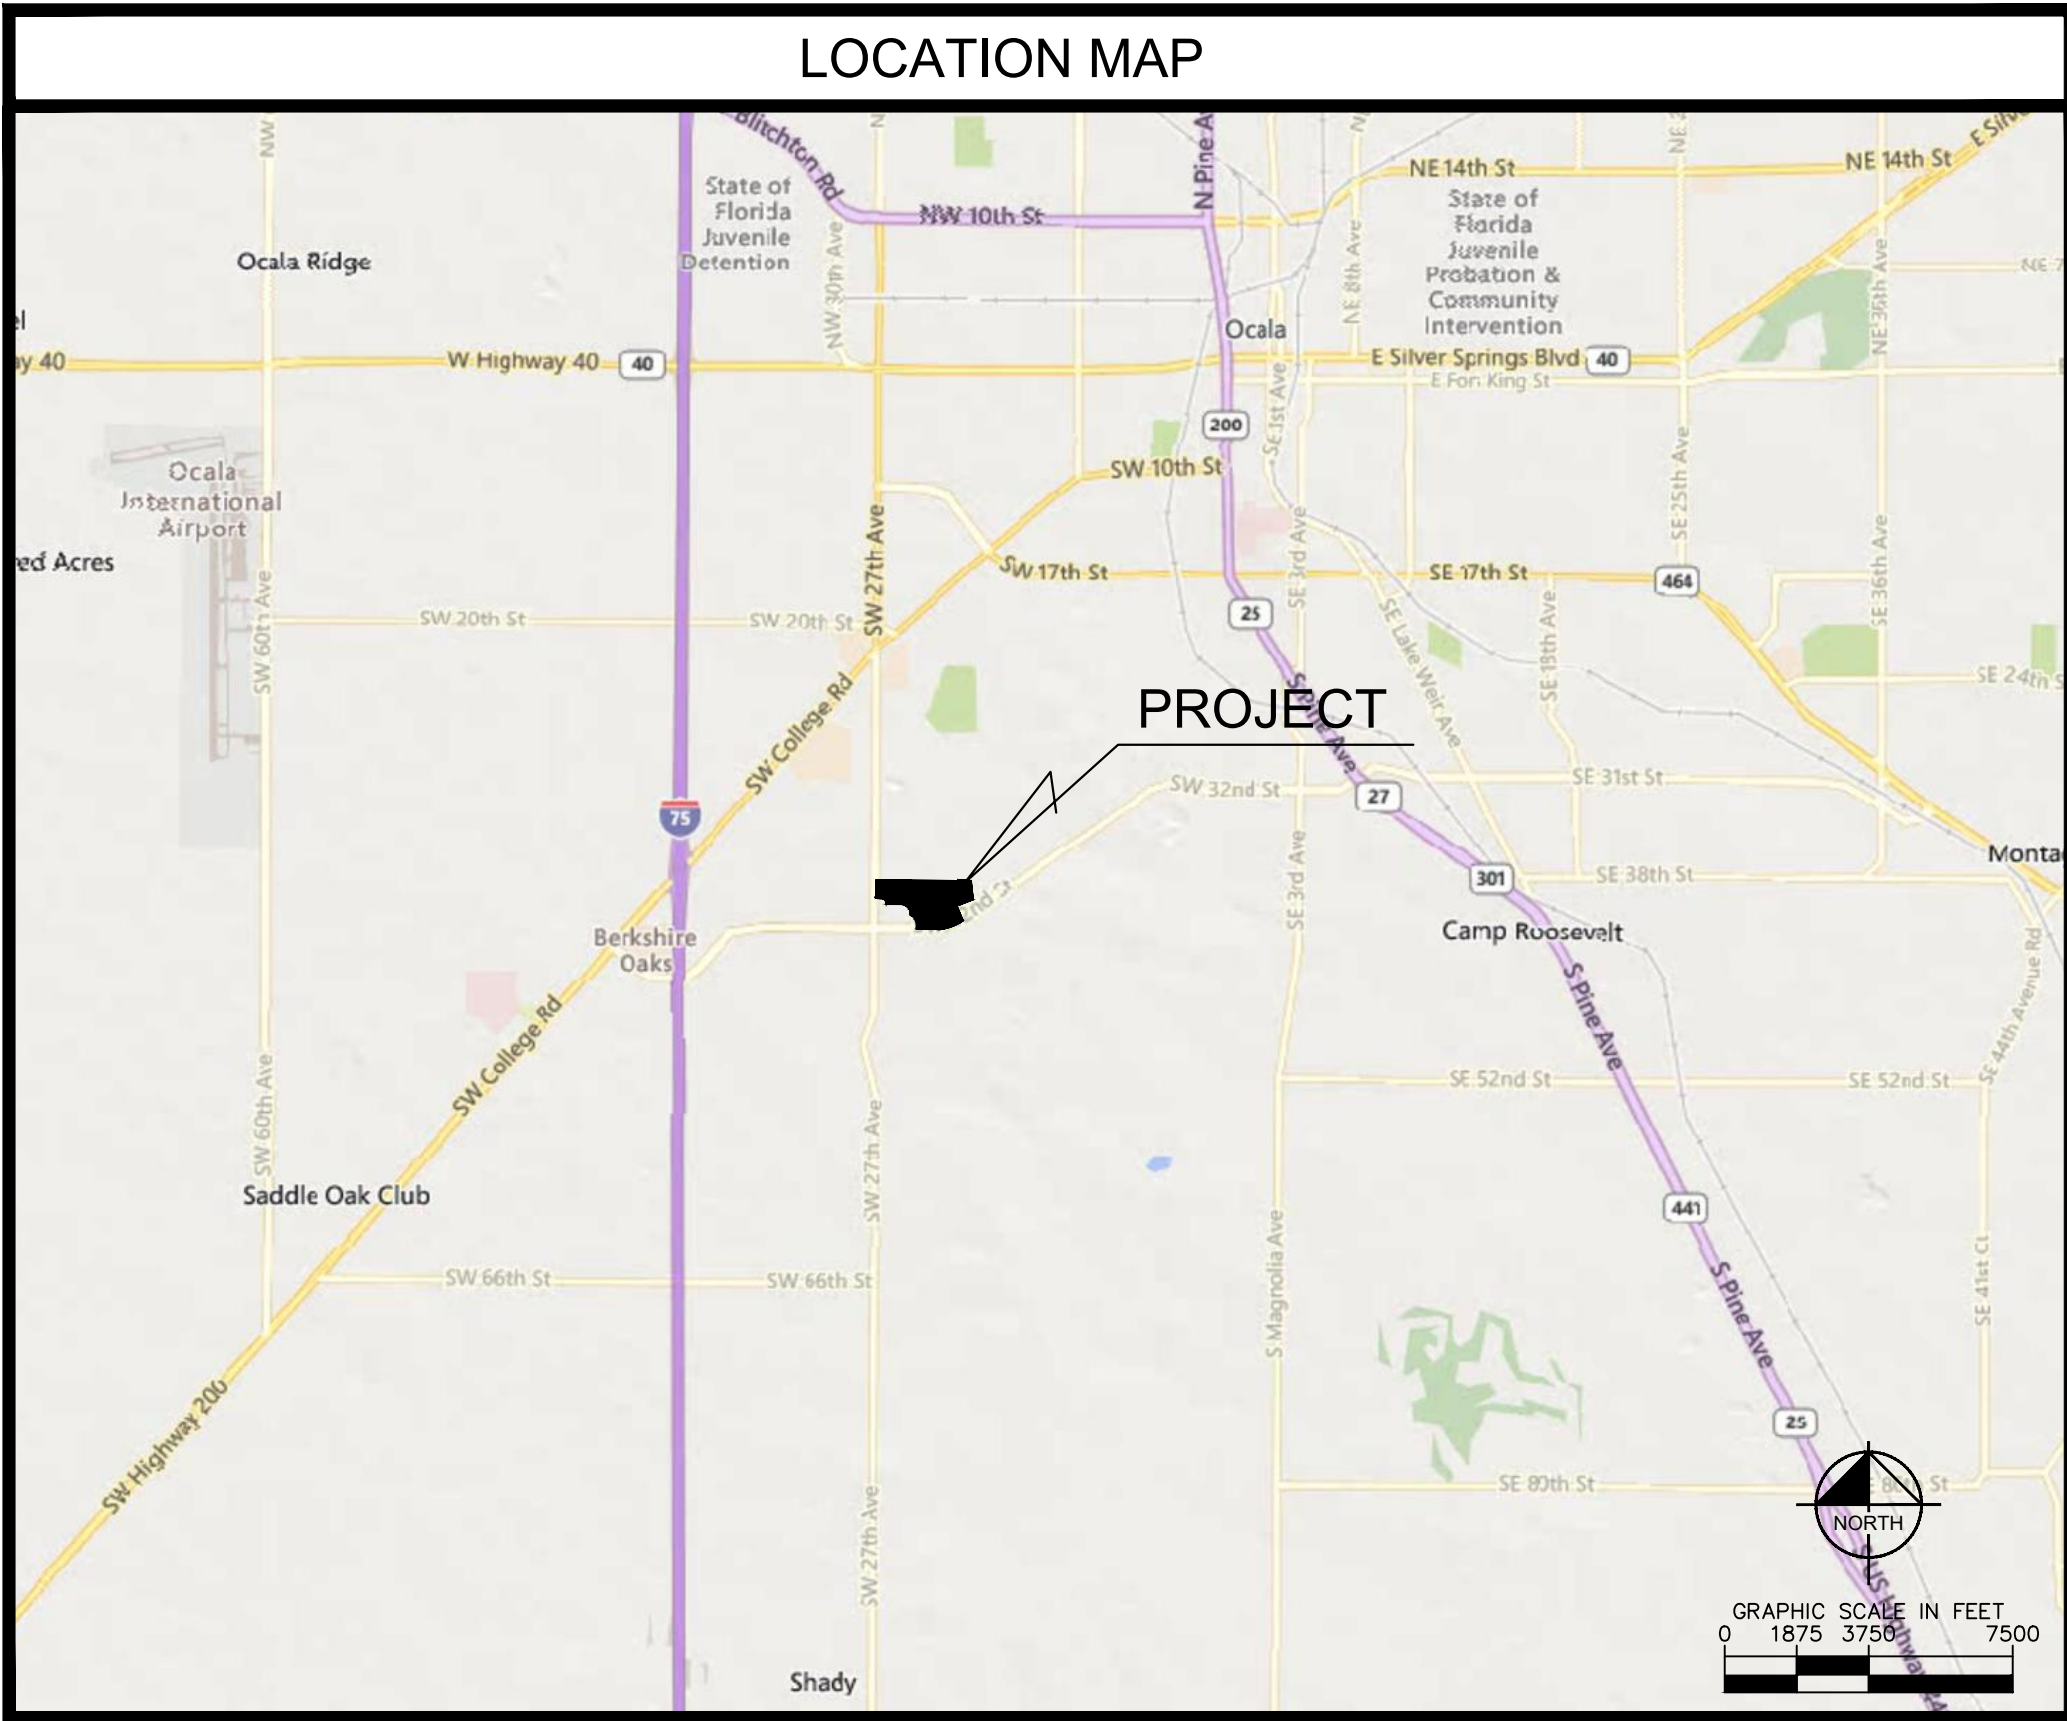

PROJECT OWNER AND CONSULTANTS:

OWNER/APPLICANT:
OCALA 42ND STREET
RESIDENTIAL, LLC
8660 NW 41ST STREET
DORAL, FL 33166

DEVELOPER:
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CIVIL ENGINEERING CONSULTANT:
KIMLEY-HORN AND ASSOCIATES, INC.
1700 SE 17TH STREET, SUITE 200
OCALA, FLORIDA 34471
(352) 438-3000

SURVEYOR:
R.M. BARRINEAU AND ASSOCIATES, INC.
OAKHURST PROFESSIONAL PARK
1309 SE 25TH LOOP, SUITE 103
OCALA, FLORIDA 34471

DRAWING INDEX:

SHEET TITLE
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PD02 - PLANNED DEVELOPMENT PLAN
PD03 - MASTER LANDSCAPE PLAN
PD04 - EXISTING TOPOGRAPHY

1 OF 2 - SURVEY
2 OF 2 - SURVEY

LEGAL DESCRIPTION:

A PORTION OF THE NORTH 1/2 OF SECTION 36 AND G.G. PERPALL GRANT, TOWNSHIP 15 SOUTH, RANGE 21 EAST AND A PORTION OF LOTS 7 AND 8, BLOCK "B" OF EL DORADO SUBDIVISION RECORDED IN PLAT BOOK "B" AT PAGES 47, 48 AND 49 OF THE PUBLIC RECORDS OF MARION COUNTY, FLORIDA, BEING MORE PARTICULARLY DESCRIBED AS FOLLOWS:

COMMENCING AT THE NORTHWEST CORNER OF SAID SECTION 36; THENCE ALONG THE NORTH BOUNDARY OF SAID SECTION 36, 889°38'59"E, A DISTANCE OF 33.00 FEET TO THE EASTERLY RIGHT OF WAY LINE OF COUNTY ROAD 475A (S.W. 27TH AVENUE) (BEING A 100 FOOT RIGHT OF WAY) AND THE POINT OF BEGINNING; THENCE CONTINUE ALONG SAID NORTH BOUNDARY ALSO BEING THE SOUTH BOUNDARY OF SAID EL DORADO SUBDIVISION, 889°38'59"E, A DISTANCE OF 2,144.75 FEET TO THE S.W. CORNER OF AN EXCEPTION TO THE WARRANTY DEED FOR LOT 7, BLOCK "B" OF SAID EL DORADO SUBDIVISION, SAID WARRANTY DEED RECORDED IN OFFICIAL RECORDS BOOK 2802, PAGE 1283 OF THE PUBLIC RECORDS OF MARION COUNTY, FLORIDA; THENCE DEPARTING SAID SOUTH BOUNDARY OF EL DORADO SUBDIVISION, ALONG THE WEST BOUNDARY OF SAID EXCEPTION, N00°17°15"E, A DISTANCE OF 14.03 FEET TO THE N.W. CORNER OF SAID EXCEPTION; THENCE ALONG THE NORTH BOUNDARY OF SAID EXCEPTION, 889°37'25"E, A DISTANCE OF 281.57 FEET TO THE N.E. CORNER OF SAID EXCEPTION; THENCE ALONG THE EAST BOUNDARY OF SAID EXCEPTION, S00°30'01"E, A DISTANCE OF 13.99 FEET TO THE S.E. CORNER OF SAID EXCEPTION, SAID POINT ALSO BEING ON THE AFOREMENTIONED SOUTH BOUNDARY OF EL DORADO SUBDIVISION; THENCE ALONG SAID SOUTH BOUNDARY, 889°41'38"E, A DISTANCE OF 57.90 FEET TO A POINT ON THE WESTERLY BOUNDARY OF A 20 FEET WIDE DRAINAGE RIGHT OF WAY AS RECORDED IN ROAD PLAT BOOK III, PAGES 119 AND 121 OF THE PUBLIC RECORDS OF MARION COUNTY, FLORIDA; THENCE DEPARTING SAID SOUTH BOUNDARY OF EL DORADO SUBDIVISION, ALONG SAID WESTERLY BOUNDARY OF DRAINAGE RIGHT OF WAY, S00°43'36"E, A DISTANCE OF 783.79 FEET; THENCE CONTINUE ALONG SAID WESTERLY BOUNDARY 503°29'21"E, A DISTANCE OF 50.45 FEET TO A POINT ON THE NORTHERLY RIGHT OF WAY LINE OF COUNTY ROAD 475C (S.W. 42ND STREET) [RIGHT OF WAY WIDTH VARIES]; THENCE ALONG SAID NORTHERLY RIGHT OF WAY LINE, S55°13'51"W, A DISTANCE OF 351.47 FEET TO THE POINT OF CURVATURE OF A CURVE CONCAVE NORTHWESTERLY, HAVING A RADIUS OF 1355.00 FEET, A CENTRAL ANGLE OF 28°30'01" AND A CHORD BEARING AND DISTANCE OF 569°14'22"W, 654.72 FEET; THENCE SOUTHWESTERLY ALONG SAID ARC AND RIGHT OF WAY LINE, A DISTANCE OF 661.31 FEET TO THE END OF SAID CURVE, THENCE CONTINUE ALONG SAID NORTHERLY RIGHT OF WAY LINE, N89°44'45"W, A DISTANCE OF 52.43 FEET TO THE S.E. CORNER OF THE PERIMETER ROAD AS DESCRIBED IN OFFICIAL RECORDS BOOK 6072, PAGE 401 OF THE PUBLIC RECORDS OF MARION COUNTY, FLORIDA, SAID POINT ALSO BEING THE POINT OF CURVATURE OF A CURVE, CONCAVE NORTHEASTERLY, HAVING A RADIUS OF 35.00 FEET, A CENTRAL ANGLE OF 89°45'34" AND A CHORD BEARING AND DISTANCE OF N44°51'56"W, 49.39 FEET; THENCE NORTHWESTERLY ALONG THE EAST BOUNDARY OF SAID LANDS AND THE ARC OF SAID CURVE, A DISTANCE OF 54.83 FEET TO THE POINT OF TANGENCY; THENCE CONTINUE ALONG THE EAST AND NORTH BOUNDARY OF SAID LANDS THE FOLLOWING SIXTEEN (16) CALLS: N00°00'40"E, A DISTANCE OF 132.48 FEET TO A POINT OF CURVATURE OF A CURVE, CONCAVE SOUTHWESTERLY, HAVING A RADIUS OF 127.00 FEET, A CENTRAL ANGLE OS 55°47'54" AND A CHORD BEARING AND DISTANCE OF N27°53'16"W, 118.85 FEET; THENCE NORTHWESTERLY ALONG THE ARC OF SAID CURVE, A DISTANCE OF 123.68 FEET TO THE POINT OF TANGENCY; THENCE N55°47'13"W, A DISTANCE OF 109.29 FEET TO A POINT OF CURVATURE OF A CURVE, CONCAVE NORTHEASTERLY, HAVING A RADIUS OF 100.00 FEET, A CENTRAL ANGLE 56°03'09" AND A CHORD BEARING AND DISTANCE OF N27°45'30"W, 51.98 FEET; THENCE NORTHWESTERLY ALONG THE ARC OF SAID CURVE, A DISTANCE OF 97.83 FEET TO THE POINT OF TANGENCY; THENCE N00°15'56"E, A DISTANCE OF 44.58 FEET TO A POINT OF CURVATURE OF A CURVE, CONCAVE SOUTHWESTERLY, HAVING A RADIUS OF 130.00 FEET, A CENTRAL ANGLE OF 55°45'06" AND A CHORD BEARING AND DISTANCE OF N27°36'37"W, 121.56 FEET; THENCE NORTHWESTERLY ALONG THE ARC OF SAID CURVE, A DISTANCE OF 126.50 FEET TO THE POINT OF TANGENCY; THENCE N55°29'10"W, A DISTANCE OF 61.26 FEET TO A POINT OF CURVATURE OF A CURVE, CONCAVE SOUTHERLY, HAVING A RADIUS OF 130.00 FEET, A CENTRAL ANGLE OF 34°14'54" AND A CHORD BEARING AND DISTANCE OF N72°36'37"W, 76.56 FEET; THENCE NORTHWESTERLY ALONG THE ARC OF SAID CURVE, A DISTANCE OF 77.71 FEET TO THE POINT OF TANGENCY; THENCE N89°44'0"W, A DISTANCE OF 381.52 FEET TO A POINT OF CURVATURE OF A CURVE, CONCAVE NORTHEASTERLY, HAVING A RADIUS OF 30.00 FEET, A CENTRAL ANGLE OF 90°00'00" AND A CHORD BEARING AND DISTANCE OF N44°44'04"W, 42.43 FEET; THENCE NORTHWESTERLY ALONG THE ARC OF SAID CURVE, A DISTANCE OF 47.12 FEET TO THE POINT OF TANGENCY; THENCE N00°15'56"E, A DISTANCE OF 19.87 FEET TO A POINT OF CURVATURE OF A CURVE, CONCAVE SOUTHWESTERLY, HAVING A RADIUS OF 124.00, A CENTRAL ANGLE OF 89°36'28" AND A CHORD BEARING AND DISTANCE OF N44°32'18"W, 174.76 FEET; THENCE NORTHWESTERLY ALONG THE ARC OF SAID CURVE, A DISTANCE OF 193.93 FEET TO THE POINT OF TANGENCY; THENCE N89°20'33"W, A DISTANCE OF 33.23 FEET; THENCE N17°09'40"W, A DISTANCE OF 51.58 FEET; THENCE N89°20'33"W, A DISTANCE OF 42.37 FEET TO A POINT OF CURVATURE OF A CURVE, CONCAVE NORTHEASTERLY, HAVING A RADIUS OF 25.00 FEET, A CENTRAL ANGLE OF 90°04'22" AND A CHORD BEARING AND DISTANCE OF N44°18'21"W, 35.38 FEET; THENCE NORTHWESTERLY ALONG THE ARC OF SAID CURVE, A DISTANCE OF 39.50 FEET TO A POINT ON THE EAST RIGHT OF WAY LINE OF THE AFOREMENTIONED COUNTY ROAD 475A (S.W. 27TH AVENUE); THENCE DEPARTING THE NORTH BOUNDARY OF SAID LANDS, ALONG THE SAID EAST RIGHT OF WAY LINE, N00°43'50"E, A DISTANCE OF 445.24 FEET TO THE POINT OF BEGINNING, SAID LANDS CONTAINING 56.72 ACRES MORE OR LESS.

PLANNED DEVELOPMENT NOTES:

- THE PLANNED DEVELOPMENT SHALL BE IN COMPLIANCE WITH ALL CONDITIONS OF ORDINANCE 2022-62.
- THE PROPERTY OWNER/DEVELOPER SUBMITTED A TRAFFIC IMPACT ANALYSIS CONSISTENT WITH THE CITY'S TRAFFIC STUDY GUIDELINES AND CONCURRENCY MANAGEMENT SYSTEM WITH THE PREVIOUSLY APPROVED P.U.D. THE PROPERTY OWNER/DEVELOPER PROVIDED ALL NECESSARY TRAFFIC IMPROVEMENTS AND MITIGATION AS DETERMINED BY THE PREVIOUS TRAFFIC ANALYSIS. THEREFORE NO FURTHER IMPROVEMENTS ARE REQUIRED IF THE TOTAL DAILY TRIPS RESULTING FROM THE PROPOSED PROJECT ARE LESS THAN OR EQUAL TO WHAT WAS PREVIOUSLY APPROVED.
- PER CODE OF ORDINANCES SECTION 122-942(6)(4), THERE SHALL BE A MINIMUM OPEN SPACE REQUIREMENT OF 25% OF THE TOTAL GROSS ACREAGE FOR ALL DEVELOPMENT IN ANY PD PROJECT. AT LEAST 10% OF THE TOTAL REQUIRED OPEN SPACE SHALL BE IN USABLE AGGREGATE FORM. AGGREGATE OPEN SPACE IS DEFINED AS COMMON OPEN SPACE AREAS THAT IS DESIGNED AND INTENDED FOR USE BY THE OCCUPANTS/RESIDENTS OF A PD.
- OPEN SPACE FOR THIS DEVELOPMENT SHALL INCLUDE ACTIVE AND PASSIVE RECREATION AREAS SUCH AS COURTYARDS, STREETS/CAPES/SIDEWALKS, PLAYGROUNDS, WATERWAYS, LANDSCAPED YARDS AND PATIOS, NATURE TRAILS, PRESERVES, AND OTHER SIMILAR OPEN SPACES. WATER RETENTION AREAS THAT ARE DESIGNED AS AESTHETIC LAKES OR PONDS FOR PASSIVE OR ACTIVE RECREATIONAL USE MAY ALSO BE COUNTED AS OPEN SPACE.
- ANY FENCED WATER RETENTION AREAS, OPEN WATER AREAS BEYOND THE PERIMETER OF THE SITE, PAVED PORTIONS OF STREET RIGHT-OF-WAY, DRIVEWAYS, OFF-STREET PARKING AREAS AND OFF-STREET LOADING AREAS SHALL NOT BE COUNTED IN DETERMINING OPEN SPACE. SIDE YARDS LESS THAN SIX FEET WIDE SHALL NOT BE COUNTED AS OPEN SPACE.
- ALL LANDSCAPING AND IRRIGATION DESIGN PLANS FOR THE ENTIRE PD ARE REQUIRED TO BE COMPLETED BY A REGISTERED LANDSCAPE ARCHITECT, AN ARBORIST OR EQUIVALENT HORTICULTURAL PROFESSIONAL SHALL EVALUATE THE TREES ON-SITE, PROVIDE NECESSARY TREE PRESERVATION REQUIREMENTS, AND BE INVOLVED IN THE FINAL CLEARING PROCESS TO ENSURE THE HEALTHY SURVIVAL OF ALL TREES SHOWN TO BE SAVED ON ANY FINAL LANDSCAPE PLANS.
- PRIOR TO APPROVAL OF ANY SITE PLAN, AN ENVIRONMENTAL ASSESSMENT MEETING THE REQUIREMENTS OF THE CITY OF OCALA LAND DEVELOPMENT CODE MUST BE APPROVED BY THE CITY OF OCALA.
- ALL IMPACT FEES WILL BE DETERMINED AT SITE PLAN REVIEW.
- ALL TRAFFIC CONTRL MARKINGS, WAYFINDING, AND LIGHTING DESIGN WILL DETERMINED AT SITE PLAN REVIEW.
- THE FINAL DESIGN, LOCATIONS, AND NUMBER OF FREESTANDING SIGNS SHALL BE REVIEWED AND APPROVED AS PART OF THE SITE PLAN WITH EACH PHASE OF DEVELOPMENT.

Kimley»Horn
© 2024 KIMLEY-HORN AND ASSOCIATES, INC.
1700 SE 17TH STREET, SUITE 200, OCALA, FLORIDA 34471
PHONE 352-438-3000
WWW.KIMLEY-HORN.COM REGISTRY NO. 35106

LICENSED PROFESSIONAL
KHA PROJECT
142263007
DATE
APRIL 2024
SCALE
AS SHOWN
DESIGNED BY
KHA
DRAWN BY
CJC
CHECKED BY
JAF
FLORIDA LICENSE NUMBER
81405
DATE

COVER SHEET

GRAND OAKS
PHASES 2 AND 3
PREPARED FOR
OCALA 42ND STREET
RESIDENTIAL, LLC
CITY OF OCALA
FLORIDA

SHEET NUMBER
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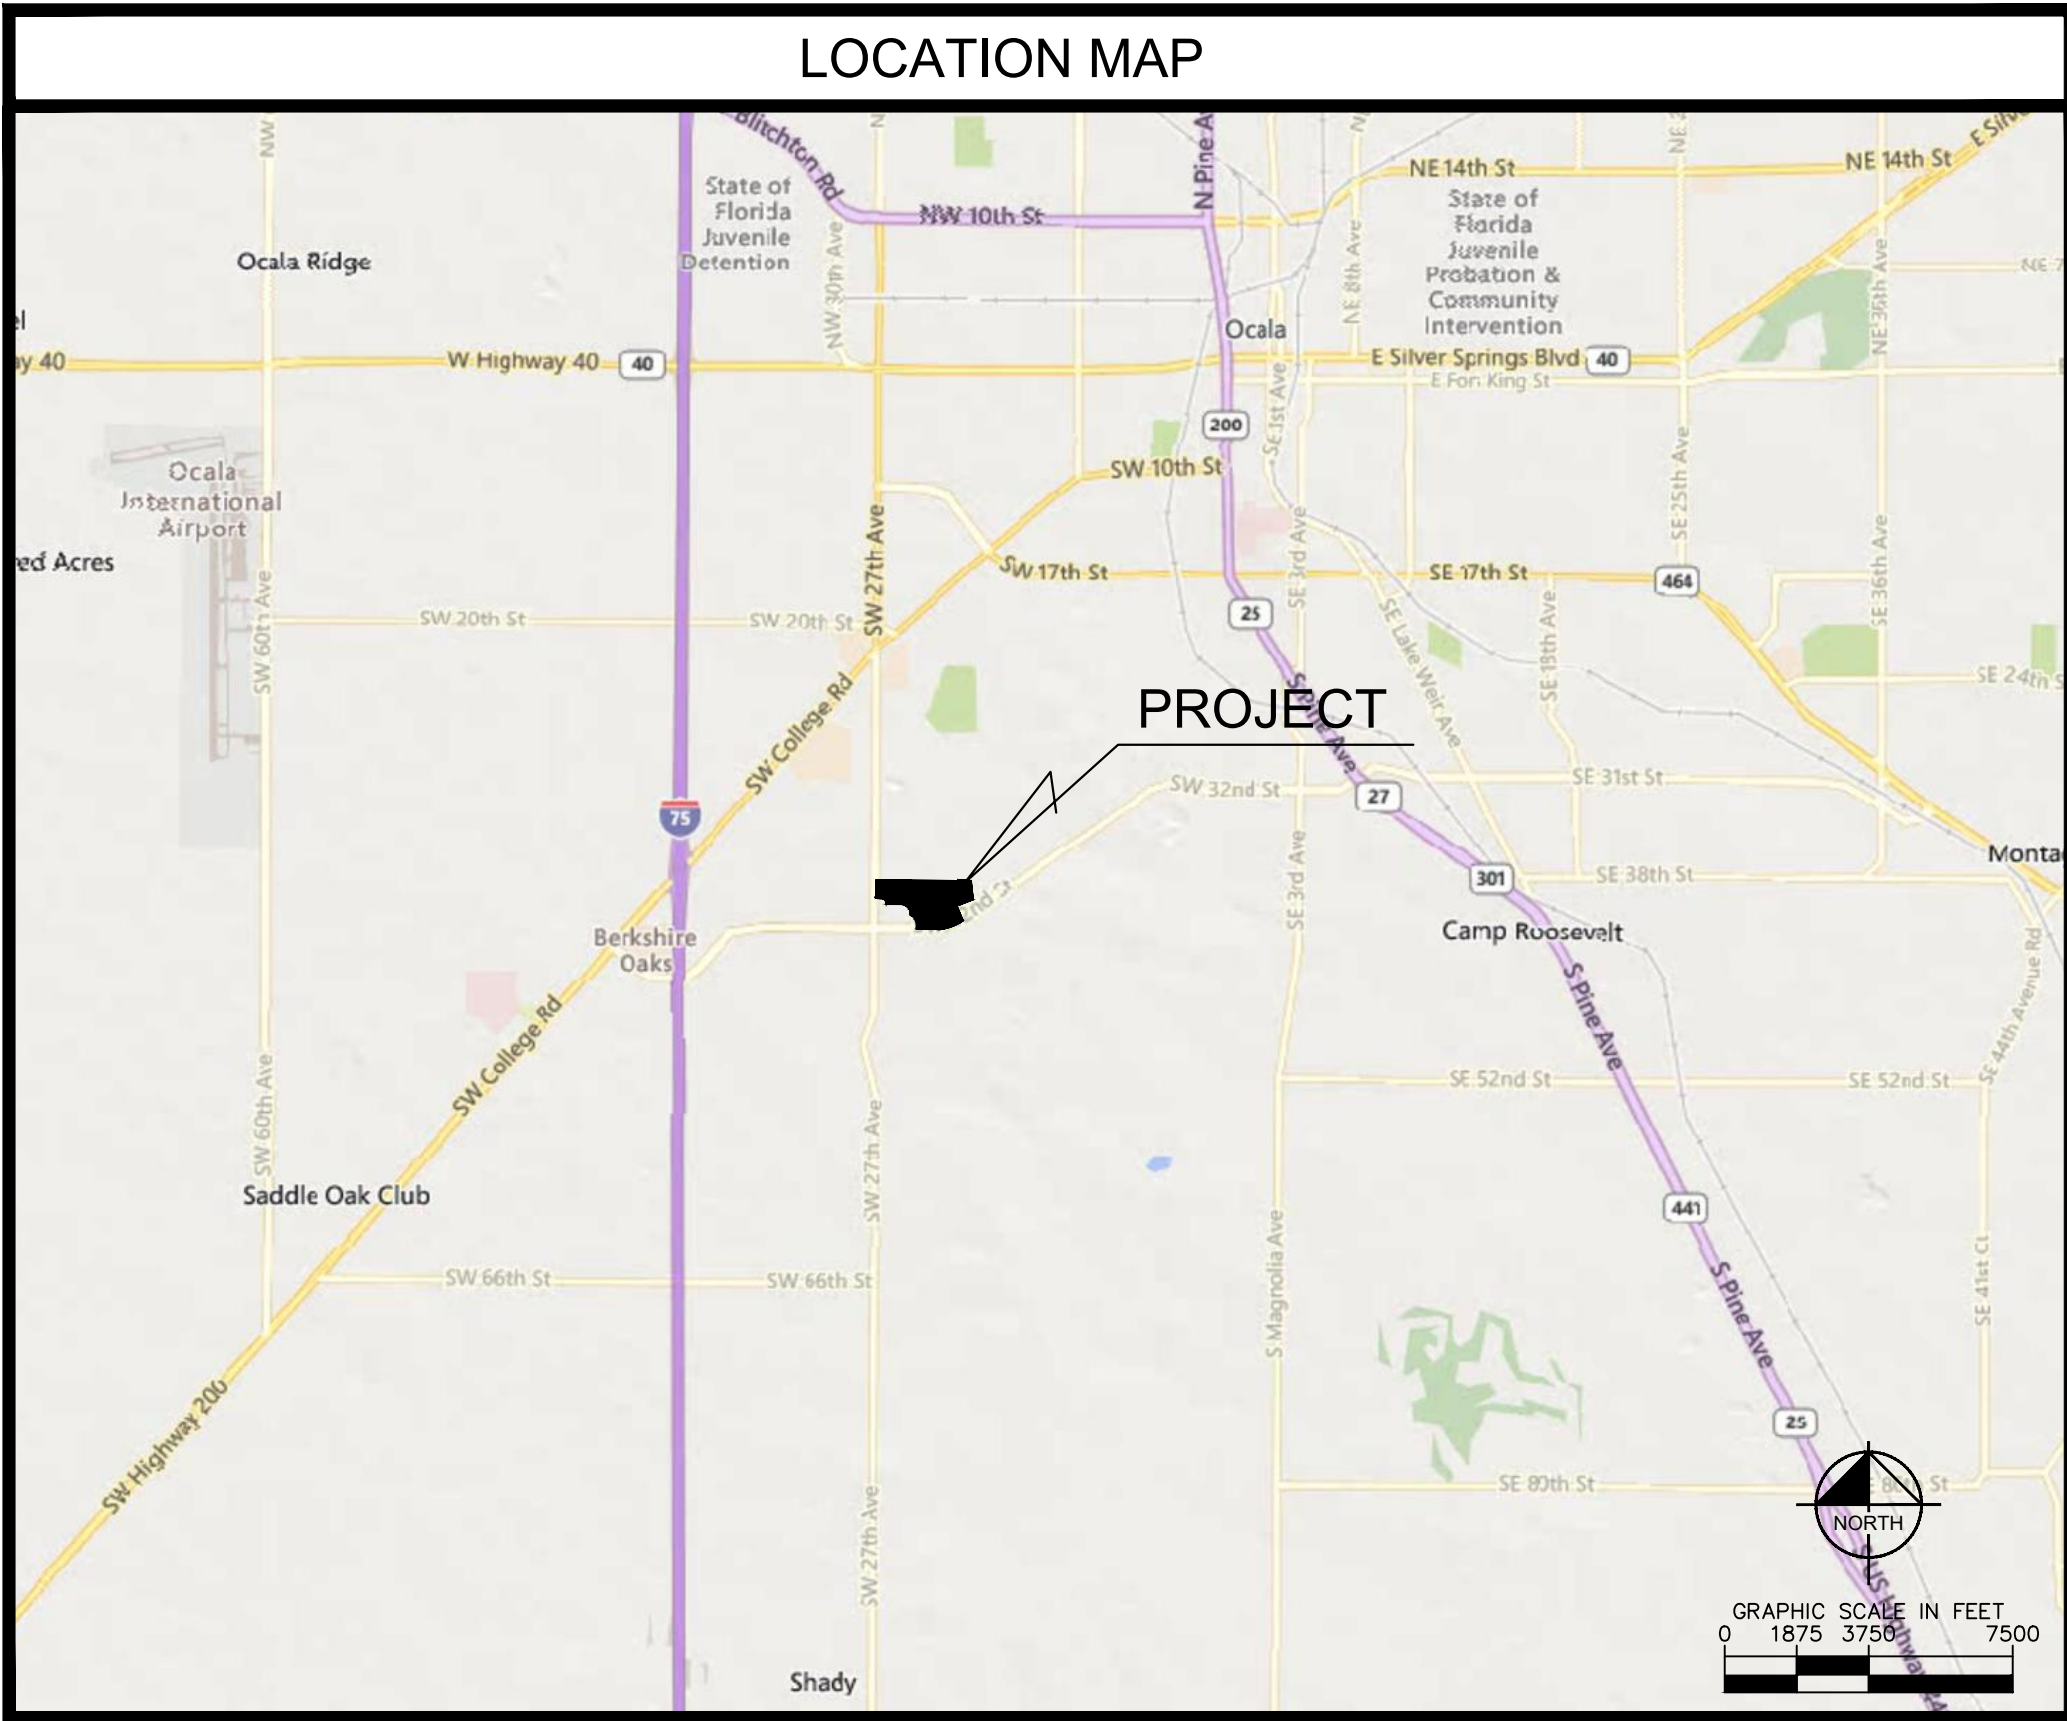
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COMMENCING AT THE NORTHWEST CORNER OF SAID SECTION 36; THENCE ALONG THE NORTH BOUNDARY OF SAID SECTION 36, 589°38'59"E, A DISTANCE OF 33.00 FEET TO THE EASTERLY RIGHT OF WAY LINE OF COUNTY ROAD 475A (S.W. 27TH AVENUE) (BEING A 100 FOOT RIGHT OF WAY) AND THE POINT OF BEGINNING; THENCE CONTINUE ALONG SAID NORTH BOUNDARY ALSO BEING THE SOUTH BOUNDARY OF SAID EL DORADO SUBDIVISION, 589°38'59"E, A DISTANCE OF 2,144.75 FEET TO THE S.W. CORNER OF AN EXCEPTION TO THE WARRANTY DEED FOR LOT 7, BLOCK "B" OF SAID EL DORADO SUBDIVISION, SAID WARRANTY DEED RECORDED IN OFFICIAL RECORDS BOOK 2802, PAGE 1283 OF THE PUBLIC RECORDS OF MARION COUNTY, FLORIDA; THENCE DEPARTING SAID SOUTH BOUNDARY OF EL DORADO SUBDIVISION, ALONG THE WEST BOUNDARY OF SAID EXCEPTION, N00°17'13"E, A DISTANCE OF 14.03 FEET TO THE N.W. CORNER OF SAID EXCEPTION; THENCE ALONG THE NORTH BOUNDARY OF SAID EXCEPTION, 589°37'25"E, A DISTANCE OF 281.57 FEET TO THE N.E. CORNER OF SAID EXCEPTION; THENCE ALONG THE EAST BOUNDARY OF SAID EXCEPTION, S00°30'01"E, A DISTANCE OF 13.99 FEET TO THE S.E. CORNER OF SAID EXCEPTION, SAID POINT ALSO BEING ON THE AFOREMENTIONED SOUTH BOUNDARY OF EL DORADO SUBDIVISION; THENCE ALONG SAID SOUTH BOUNDARY, 589°41'38"E, A DISTANCE OF 57.90 FEET TO A POINT ON THE WESTERLY BOUNDARY OF A 20 FEET WIDE DRAINAGE RIGHT OF WAY AS RECORDED IN ROAD PLAT BOOK III, PAGES 119 AND 121 OF THE PUBLIC RECORDS OF MARION COUNTY, FLORIDA; THENCE DEPARTING SAID SOUTH BOUNDARY OF EL DORADO SUBDIVISION, ALONG SAID WESTERLY BOUNDARY OF DRAINAGE RIGHT OF WAY, S00°43'36"E, A DISTANCE OF 783.79 FEET; THENCE CONTINUE ALONG SAID WESTERLY BOUNDARY 503°29'21"E, A DISTANCE OF 50.45 FEET TO A POINT ON THE NORTHERLY RIGHT OF WAY LINE OF COUNTY ROAD 475C (S.W. 42ND STREET) [RIGHT OF WAY WIDTH VARIES]; THENCE ALONG SAID NORTHERLY RIGHT OF WAY LINE, S55°13'51"W, A DISTANCE OF 351.47 FEET TO THE POINT OF CURVATURE OF A CURVE CONCAVE NORTHWESTERLY, HAVING A RADIUS OF 1355.00 FEET, A CENTRAL ANGLE OF 28°00'01" AND A CHORD BEARING AND DISTANCE OF 569°14'22"W, 654.72 FEET; THENCE SOUTHWESTERLY ALONG SAID ARC AND RIGHT OF WAY LINE, A DISTANCE OF 661.31 FEET TO THE END OF SAID CURVE, THENCE CONTINUE ALONG SAID NORTHERLY RIGHT OF WAY LINE, N89°44'45"W, A DISTANCE OF 52.43 FEET TO THE S.E. CORNER OF THE PERIMETER ROAD AS DESCRIBED IN OFFICIAL RECORDS BOOK 6072, PAGE 401 OF THE PUBLIC RECORDS OF MARION COUNTY, FLORIDA, SAID POINT ALSO BEING THE POINT OF CURVATURE OF A CURVE, CONCAVE NORTHEASTERLY, HAVING A RADIUS OF 35.00 FEET, A CENTRAL ANGLE OF 89°45'34" AND A CHORD BEARING AND DISTANCE OF N44°51'56"W, 49.39 FEET; THENCE NORTHWESTERLY ALONG THE EAST BOUNDARY OF SAID LANDS AND THE ARC OF SAID CURVE, A DISTANCE OF 54.83 FEET TO THE POINT OF TANGENCY; THENCE CONTINUE ALONG THE EAST AND NORTH BOUNDARY OF SAID LANDS THE FOLLOWING SIXTEEN (16) CALLS: N00°00'40"E, A DISTANCE OF 132.48 FEET TO A POINT OF CURVATURE OF A CURVE, CONCAVE SOUTHWESTERLY, HAVING A RADIUS OF 127.00 FEET, A CENTRAL ANGLE OS 55°47'54" AND A CHORD BEARING AND DISTANCE OF N27°53'16"W, 118.85 FEET; THENCE NORTHWESTERLY ALONG THE ARC OF SAID CURVE, A DISTANCE OF 123.68 FEET TO THE POINT OF TANGENCY; THENCE N55°47'13"W, A DISTANCE OF 109.29 FEET TO A POINT OF CURVATURE OF A CURVE, CONCAVE NORTHEASTERLY, HAVING A RADIUS OF 100.00 FEET, A CENTRAL ANGLE 56°03'09" AND A CHORD BEARING AND DISTANCE OF N27°45'30"W, 51.98 FEET; THENCE NORTHWESTERLY ALONG THE ARC OF SAID CURVE, A DISTANCE OF 97.83 FEET TO THE POINT OF TANGENCY; THENCE N00°15'56"E, A DISTANCE OF 44.58 FEET TO A POINT OF CURVATURE OF A CURVE, CONCAVE SOUTHWESTERLY, HAVING A RADIUS OF 130.00 FEET, A CENTRAL ANGLE OF 55°45'06" AND A CHORD BEARING AND DISTANCE OF N27°36'37"W, 121.56 FEET; THENCE NORTHWESTERLY ALONG THE ARC OF SAID CURVE, A DISTANCE OF 126.50 FEET TO THE POINT OF TANGENCY; THENCE N55°29'10"W, A DISTANCE OF 61.26 FEET TO A POINT OF CURVATURE OF A CURVE, CONCAVE SOUTHERLY, HAVING A RADIUS OF 130.00 FEET, A CENTRAL ANGLE OF 34°14'54" AND A CHORD BEARING AND DISTANCE OF N72°36'37"W, 76.56 FEET; THENCE NORTHWESTERLY ALONG THE ARC OF SAID CURVE, A DISTANCE OF 77.71 FEET TO THE POINT OF TANGENCY; THENCE N89°44'0"W, A DISTANCE OF 381.52 FEET TO A POINT OF CURVATURE OF A CURVE, CONCAVE NORTHEASTERLY, HAVING A RADIUS OF 30.00 FEET, A CENTRAL ANGLE OF 90°00'00" AND A CHORD BEARING AND DISTANCE OF N44°44'04"W, 42.43 FEET; THENCE NORTHWESTERLY ALONG THE ARC OF SAID CURVE, A DISTANCE OF 47.12 FEET TO THE POINT OF TANGENCY; THENCE N00°15'56"E, A DISTANCE OF 19.87 FEET TO A POINT OF CURVATURE OF A CURVE, CONCAVE SOUTHWESTERLY, HAVING A RADIUS OF 124.00, A CENTRAL ANGLE OF 89°36'28" AND A CHORD BEARING AND DISTANCE OF N44°32'18"W, 174.76 FEET; THENCE NORTHWESTERLY ALONG THE ARC OF SAID CURVE, A DISTANCE OF 193.93 FEET TO THE POINT OF TANGENCY; THENCE N89°20'33"W, A DISTANCE OF 33.23 FEET; THENCE N17°09'40"W, A DISTANCE OF 51.58 FEET; THENCE N89°20'33"W, A DISTANCE OF 42.37 FEET TO A POINT OF CURVATURE OF A CURVE, CONCAVE NORTHEASTERLY, HAVING A RADIUS OF 25.00 FEET, A CENTRAL ANGLE OF 90°04'22" AND A CHORD BEARING AND DISTANCE OF N44°18'21"W, 35.38 FEET; THENCE NORTHWESTERLY ALONG THE ARC OF SAID CURVE, A DISTANCE OF 39.50 FEET TO A POINT ON THE EAST RIGHT OF WAY LINE OF THE AFOREMENTIONED COUNTY ROAD 475A (S.W. 27TH AVENUE); THENCE DEPARTING THE NORTH BOUNDARY OF SAID LANDS, ALONG THE SAID EAST RIGHT OF WAY LINE, N00°43'50"E, A DISTANCE OF 445.24 FEET TO THE POINT OF BEGINNING, SAID LANDS CONTAINING 56.72 ACRES MORE OR LESS.

PLANNED DEVELOPMENT NOTES:

- THE PLANNED DEVELOPMENT SHALL BE IN COMPLIANCE WITH ALL CONDITIONS OF ORDINANCE 2022-62.
- THE PROPERTY OWNER/DEVELOPER SUBMITTED A TRAFFIC IMPACT ANALYSIS CONSISTENT WITH THE CITY'S TRAFFIC STUDY GUIDELINES AND CONCURRENCY MANAGEMENT SYSTEM WITH THE PREVIOUSLY APPROVED P.U.D. THE PROPERTY OWNER/DEVELOPER PROVIDED ALL NECESSARY TRAFFIC IMPROVEMENTS AND MITIGATION AS DETERMINED BY THE PREVIOUS TRAFFIC ANALYSIS. THEREFORE NO FURTHER IMPROVEMENTS ARE REQUIRED IF THE TOTAL DAILY TRIPS RESULTING FROM THE PROPOSED PROJECT ARE LESS THAN OR EQUAL TO WHAT WAS PREVIOUSLY APPROVED.
- PER CODE OF ORDINANCES SECTION 122-942(6)(4), THERE SHALL BE A MINIMUM OPEN SPACE REQUIREMENT OF 25% OF THE TOTAL GROSS ACREAGE FOR ALL DEVELOPMENT IN ANY PD PROJECT. AT LEAST 10% OF THE TOTAL REQUIRED OPEN SPACE SHALL BE IN USABLE AGGREGATE FORM. AGGREGATE OPEN SPACE IS DEFINED AS COMMON OPEN SPACE AREAS THAT IS DESIGNED AND INTENDED FOR USE BY THE OCCUPANTS/RESIDENTS OF A PD.
- OPEN SPACE FOR THIS DEVELOPMENT SHALL INCLUDE ACTIVE AND PASSIVE RECREATION AREAS SUCH AS COURTYARDS, STREETS/CAPES/SIDEWALKS, PLAYGROUNDS, WATERWAYS, LANDSCAPED YARDS AND PATIOS, NATURE TRAILS, PRESERVES, AND OTHER SIMILAR OPEN SPACES. WATER RETENTION AREAS THAT ARE DESIGNED AS AESTHETIC LAKES OR PONDS FOR PASSIVE OR ACTIVE RECREATIONAL USE MAY ALSO BE COUNTED AS OPEN SPACE.
- ANY FENCED WATER RETENTION AREAS, OPEN WATER AREAS BEYOND THE PERIMETER OF THE SITE, PAVED PORTIONS OF STREET RIGHT-OF-WAY, DRIVEWAYS, OFF-STREET PARKING AREAS AND OFF-STREET LOADING AREAS SHALL NOT BE COUNTED IN DETERMINING OPEN SPACE. SIDE YARDS LESS THAN SIX FEET WIDE SHALL NOT BE COUNTED AS OPEN SPACE.
- ALL LANDSCAPING AND IRRIGATION DESIGN PLANS FOR THE ENTIRE PD ARE REQUIRED TO BE COMPLETED BY A REGISTERED LANDSCAPE ARCHITECT, AN ARBORIST OR EQUIVALENT HORTICULTURAL PROFESSIONAL SHALL EVALUATE THE TREES ON-SITE, PROVIDE NECESSARY TREE PRESERVATION REQUIREMENTS, AND BE INVOLVED IN THE FINAL CLEARING PROCESS TO ENSURE THE HEALTHY SURVIVAL OF ALL TREES SHOWN TO BE SAVED ON ANY FINAL LANDSCAPE PLANS.
- PRIOR TO APPROVAL OF ANY SITE PLAN, AN ENVIRONMENTAL ASSESSMENT MEETING THE REQUIREMENTS OF THE CITY OF OCALA LAND DEVELOPMENT CODE MUST BE APPROVED BY THE CITY OF OCALA.
- ALL IMPACT FEES WILL BE DETERMINED AT SITE PLAN REVIEW.
- ALL TRAFFIC CONTRL MARKINGS, WAYFINDING, AND LIGHTING DESIGN WILL DETERMINED AT SITE PLAN REVIEW.
- THE FINAL DESIGN, LOCATIONS, AND NUMBER OF FREESTANDING SIGNS SHALL BE REVIEWED AND APPROVED AS PART OF THE SITE PLAN WITH EACH PHASE OF DEVELOPMENT.

Kimley»Horn
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1700 SE 17TH STREET, SUITE 200, OCALA, FLORIDA 34471
PHONE 352-438-3000
WWW.KIMLEY-HORN.COM REGISTRY NO. 35106

LICENSED PROFESSIONAL
KHA PROJECT
142263007
DATE
APRIL 2024
SCALE
AS SHOWN
DESIGNED BY
KHA
DRAWN BY
CJC
CHECKED BY
JAF
FLORIDA LICENSE NUMBER
81405
DATE

COVER SHEET

GRAND OAKS
PHASES 2 AND 3
PREPARED FOR
OCALA 42ND STREET
RESIDENTIAL, LLC
CITY OF OCALA
FLORIDA

SHEET NUMBER
PD01



No.	REVISIONS	DATE	BY
1	CITY OF OCALA RAI	3-29-2024	CJC

Kimley»Horn

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1700 SE 17TH STREET, SUITE 200, OCALA, FLORIDA 34471
PHONE 352-439-3000
WWW.KIMLEY-HORN.COM REGISTRY NO. 35106

LICENSED PROFESSIONAL
JAMESON A. FREDERICK, P.E.
FLORIDA LICENSE NUMBER 81405

KHA PROJECT 142263007
DATE JUNE 2024
SCALE AS SHOWN
DESIGNED BY KHA
DRAWN BY CJC
CHECKED BY JAF

**PLANNED
DEVELOPMENT
PLAN**

GRAND OAKS
PHASES 2 AND 3
PREPARED FOR
OCALA 42ND STREET
RESIDENTIAL, LLC
CITY OF OCALA FLORIDA

SHEET NUMBER
PD02

SITE DATA TABLE	
PROJECT LOCATION	GRAND OAKS TOWN CENTER
OWNER/DEVELOPERS	OWNER: OCALA 42ND STREET RESIDENTIAL, LLC 8660 NW 41ST STREET DORAL, FLORIDA 33166 DEVELOPER: LEON OCALA HOLDINGS III, LLC 8600 NW 41ST STREET DORAL, FLORIDA 33166
PROPOSED ZONING	PD (PLANNED DEVELOPMENT)
FUTURE LAND USE	LOW INTENSITY
PARCEL ACCOUNT NUMBERS	23930-000-00, 23930-002-00, 23930-003-00, 23930-005-00, 23930-003-01, 23930-003-03
SITE GROSS AREA	±56.72 ACRES
OPEN SPACE: REQUIRED TOTAL OPEN SPACE (MIN.) REQUIRED AGGREGATE OPEN SPACE*	±14.18 AC. (25% OF GROSS ACREAGE) ±14.02 AC. (10% OF TOTAL OPEN SPACE)
MAXIMUM FLOOR AREA RATIO	0.50 (50.0%)
BUILDING SETBACKS	FRONT YARD = 20' SIDE YARD = 8' REAR YARD = 25'
STREET WIDENING SETBACK	ZERO
PROPOSED BUFFERS	NORTH = 50' NATURAL ENHANCED BUFFER WEST = 25' NATURAL ENHANCED BUFFER SOUTH/EAST = 10' LANDSCAPED BUFFER
MAXIMUM BUILDING HEIGHT	50 FEET
ROADS	PRIVATE
UTILITIES	CITY OF OCALA
DRAINAGE	PRIVATE
AMENITIES	COMMUNITY CLUBHOUSE, POOL, LANDSCAPED & OPEN AREAS

* AGGREGATE OPEN SPACE SHALL BE PROVIDED PER SECTION 122-942(4) OF THE CITY OF OCALA LAND DEVELOPMENT REGULATIONS.

DEVELOPMENT PROGRAM TABLE			
DESIGNATION	ACREAGE	ALLOWABLE USES	DENSITY
COM	± 4.26	• PROFESSIONAL OFFICE • MEDICAL OFFICE • OTHER USES ALLOWED WITHIN THE B-2 ZONING CLASSIFICATION	UP TO 30,000 SQ. FT.*
RES	± 52.46	• MULTIFAMILY RESIDENTIAL • TOWNHOMES • RECREATIONAL USES	UP TO 480 MULTI-FAMILY UNITS AND UP TO 48 TOWNHOMES*

* THE PROPOSED DENSITIES MAY BE CHANGED AS DEVELOPMENT OCCURS WITHIN THE PLANNED DEVELOPMENT SO LONG AS THE TOTAL DAILY TRIPS DO NOT EXCEED THOSE DEFINED IN THE PREVIOUSLY APPROVED P.U.D. AND TRAFFIC IMPACT ANALYSIS.

PARKING REQUIREMENTS:
EACH DEVELOPMENT WITHIN THE PD SHALL MEET THE REQUIREMENTS IN SECTIONS 122-1001 THROUGH 122-1016 OF THE CITY OF OCALA CODE OF ORDINANCES.

WAYFINDING SIGNAGE:
WAYFINDING/INTERNAL SIGN LOCATIONS AND DESIGN WILL BE SHOWN AT THE DEVELOPMENT PLAN STAGE.

DESIGN:
THIS PLAN IS CONCEPTUAL IN NATURE. FINAL LAYOUTS WILL BE DETERMINED AT THE SITE PLAN STAGE AND ADJUSTED BASED ON ENGINEERING AND MARKET FACTORS.

PHASING:
ANTICIPATED PHASING OF THE PROJECT IS AS SHOWN. PHASING MAY BE MODIFIED DURING DEVELOPMENT. PHASES 2 AND 3 ARE INDEPENDENT OF EACH OTHER.

✱ GENERAL LOCATION OF GROUND MOUNTED MAIN SIGNAGE, SEE PD STANDARDS FOR REQUIREMENTS

